

Adam J. Glassman, R.A. 2 Worthington St Cambridge, MA 02138 Tel. 617-412-8450




DRAWING LIST

COVER SHEET

SURVEYED SITE PLAN

0.1	SITE PHOTOS
0.2	SITE PHOTOS


- Z1.1 EXISTING FAR PLANSZ1.2 PROPOSED FAR PLANS
- L1.1 EXISTING SITE AND LANDSCAPING PLAN
 L1.2 PROPOSED SITE AND LANDSCAPING PLAN
- D1.1 EXISTING PLANS
- D2.1 EXISTING EXTERIOR ELEVATIONS
- D2.2 EXISTING EXTERIOR ELEVATIONS
- D2.3 EXISTING EXTERIOR ELEVATIONS
- A1.1 PROPOSED FIRST & SECOND FLOOR PLANS
- A1.2 PROPOSED BASEMENT & ROOF PLANS
- A2.1 PROPOSED EXTERIOR ELEVATIONS
- A2.2 PROPOSED EXTERIOR ELEVATIONS
- A2.3 PROPOSED EXTERIOR ELEVATIONS
- A2.4 PROPOSED EXTERIOR ELEVATIONS

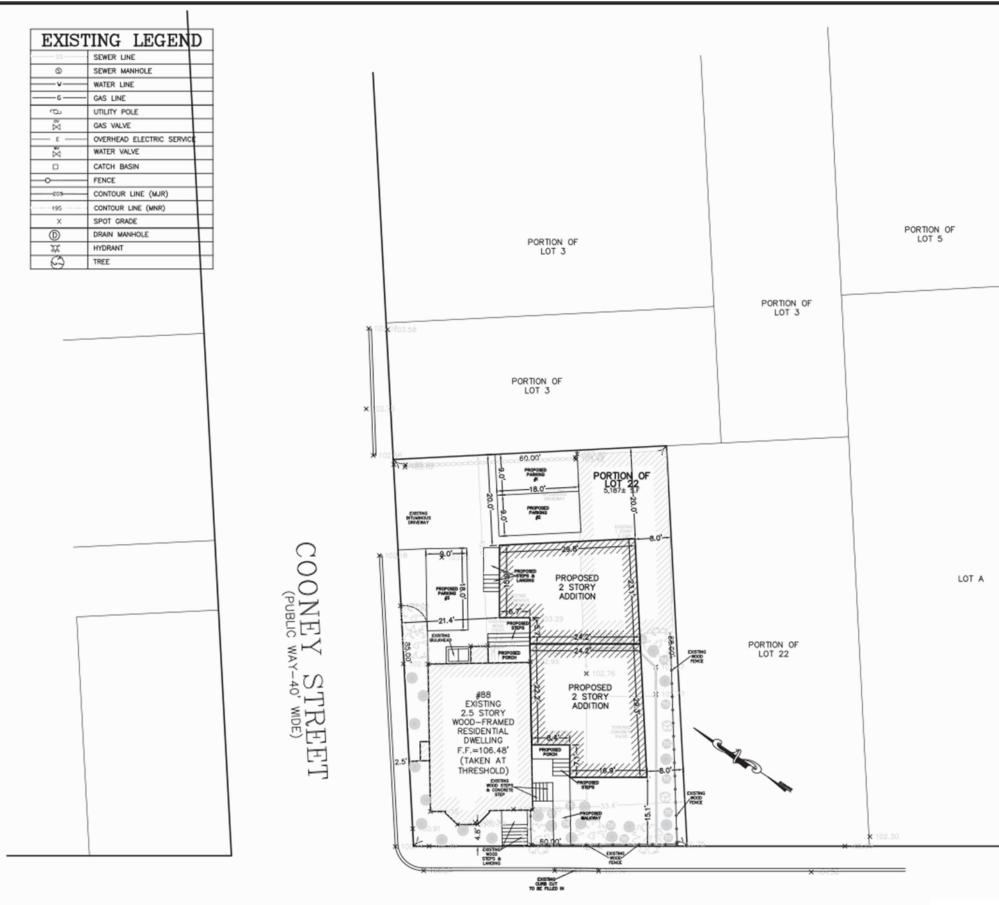

ZONING LEGEND ZONING DISTRICT: RB RESIDENCE B REQUIRED **EXISTING** PROPOSED COMPLIANCE FXISTING 5,187 S.F. MIN. LOT SIZE 7,500 S.F 5,187 S.F. NON-CONFORMING EXISTING NON-CONFORMING MIN. YARD FRONT 15' 4.8" 4.8" SIDE (RIGHT) 8* 33.4 8.0" YES EXISTING NON-CONFORMING SIDE (LEFT) 8* 2.5 2.5 REAR 20' 42.0' 20.0 YES MAX. LOT COVERAGE 30% ± 40.0% ± YES 50% LANDSCAPED AREA 25% YES 15.2% ± $31.0\% \pm$ YES 50" 60.0" 60.0" MIN. FRONTAGE MAX. BLDG. HEIGHT 40° 33.62°± 33.62°± YES MAX. STORIES 2.5 2.5 YES MAX. FAR 0.37 0.77 YES 1.0 35% MIN. PERVIOUS AREA 35% ± 44.0% ± YES MIN. LOT AREA PER-DWELLING UNIT 1,500 S.F. 5,187 S.F. 1,729S.F. YES 5.0 NO MIN. PARKING SPACES


NOTE

- 1. INFORMATION SHOWN ON THIS PLAN IS THE RESULT OF A FIELD SURVEY PERFORMED BY PETER NOLAN & ASSOCIATES LLC AS OF 9-1-17.
- DEED REFERENCE BOOK 50481 PAGE 468, MIDDLESEX SOUTH DISTRICT REGISTRY OF DEEDS.
- 3. THIS PLAN IS NOT INTENDED TO BE RECORDED.
- 4. I CERTIFY THAT THE DWELLING SHOWN IS NOT LOCATED WITHIN A SPECIAL FLOOD HAZARD ZONE. IT IS LOCATED IN ZONE X, ON FLOOD HAZARD BOUNDARY MAP NUMBER 25017C0438E, PANEL NUMBER 0438E, COMMUNITY NUMBER: 25017, DATED JUNE 4, 2010.
- THIS PLAN DOES NOT SHOW ANY UNRECORDED OR UNWRITTEN EASEMENTS WHICH MAY EXIST. A REASONABLE AND DILIGENT ATTEMPT HAS BEEN MADE TO OBSERVE ANY APPARENT USES OF THE LAND; HOWEVER THIS NOT CONSTITUTE A GUARANTEE THAN NO SUCH EASEMENTS EXIST.
- 6. FIRST FLOOR ELEVATIONS ARE TAKEN AT THRESHOLD.

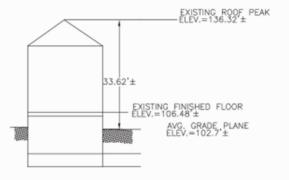

EXISTING PROFILE NOT TO SCALE

LINE STREET
(PUBLIC WAY-VARIABLE WIDTH)

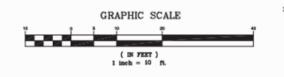



SCALE 1*=10'	\vdash				
DATE	\vdash				1
7/18/2017	REV	DATE	REVISION	BY]
SHEET 1			88 LINE STREET]
PLAN NO.	┑		SOMERVILLE		
1 OF 1			MASSACHUSETTS		l
CUENT:	\top		PROPOSED		SHEET NO.
DRAWN BY	┖		PLOT PLAN		_
CHKD BY			ETER NOLAN & ASSOCIATES LL ND SURVEYORS/CIVIL ENGINEERING CONSULTANT		

PETER NOLAN & ASSOCIATES LLC
LAND SURVEYORS/CIVIL ENGINEERING CONSULTANTS
697 CHARRIDGE STREET, SUITE 103 BROSHTON NA 02135
PHONE: 857 891 7478/617 782 1533 FAX: 617 202 5691

EMAIL: pnolan@pnasurveyors.com





VIEWS FROM LINE STREET









VIEWS FROM COONEY STREET





RIGHT SIDE ELEVATION



RIGHT SIDE YARD




REAR ELEVATION






REAR YARD FROM COONEY ST

EXISTING FAR PLANS

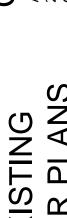


GCD ARCHITECTS

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THIRD FLOOR PLAN
Ceiling Height = 6'-6"

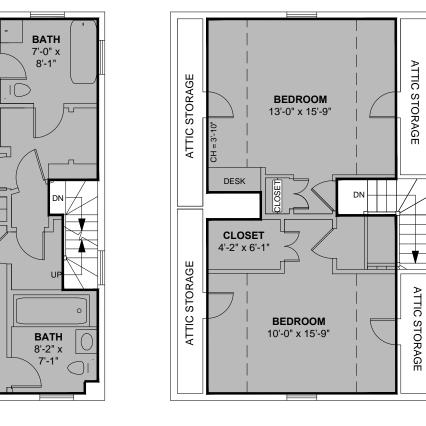645 SF NFA



EXISTING FAR PLANS
Scale: 1/8" = 1'-0"

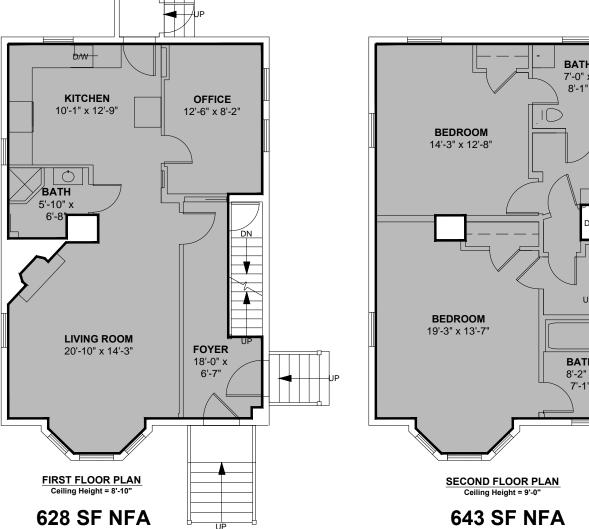BASEMENT PLAN
Ceiling Height = 6'-8"

D

w

WH

UTILITY / STORAGE 30'-10" x 20'-10"

PROPOSED **FAR PLANS**

ARCHITECT

CLOSET CLOSET EXISTING HOUSE UNIT 1 NOT IN SCOPE UNIT 3 534 NSF

UNIT 2 🔤 🖁 510 NSF

PROPOSED PLANS FIRST FLOOR
| Scale: 1/8" = 1'-0"

EXISTING HOUSE

NOT IN SCOPE

1,916 SF NFA

UNIT 1

UNIT 2 510 NSF

UNIT 3 534 NSF

25'-2 1/4" PROPOSED (2) NEW DWELLING UNITS

1,916 EXISTING NSF + 2,088 PROPOSED NSF = 4,004 TOTAL NSF

KITCHEN

PROPOSED PLANS SECOND FLOOR
Scale: 1/8" = 1'-0"

25'-2 1/4" PROPOSED (2) NEW DWELLING UNITS

STREET (PUBLIC WAY-VARIABLE WIDTH)

LANDSCAPE **EXISTING**

ARCHITECTS GCD

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SITE

SCALE: $\frac{1}{32}$ " = 1'-0"

Somerville 88 Line Street

JULY 20, 2017 ZBA REVIEW

BUFFER

(PUBLIC WAY-VARIABLE WIDTH)

Somerville JULY 20, 2017 ZBA REVIEW 88 Line Street

ARCHITECTS GCD


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LANDSCAPE ROPOSE

SIT


SCALE: $\frac{1}{32}$ " = 1'-0"


EXISTING PLANS

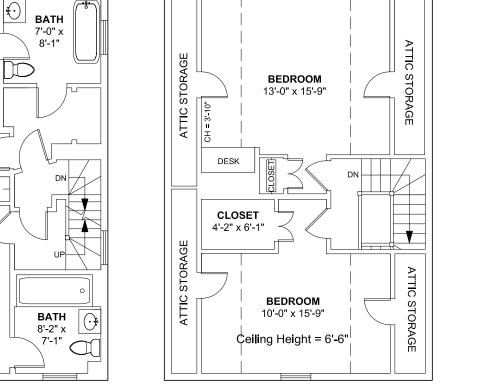

LINE STREET SIDE

4 EXISTING THIRD FLOOR PLAN
Scale: 1/8" = 1'-0"

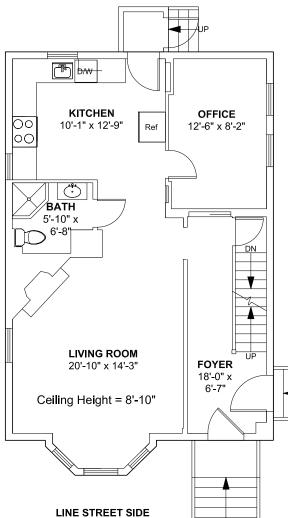

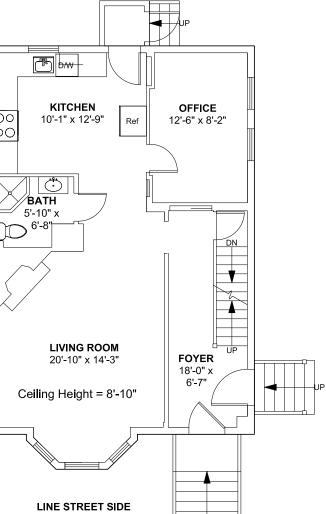

BEDROOM 14'-3" x 12'-8" BEDROOM 19'-3" x 13'-7" Ceiling Height = 9'-0"

LINE STREET SIDE

3 EXISTING SECOND FLOOR PLAN
Scale: 1/8" = 1'-0"

EXISTING BASEMENT PLAN
Scale: 1/8" = 1'-0"

LINE STREET SIDE

Ceiling Height = 6'-8"

ELECTRICAL

w

WH

UTILITY / STORAGE


30'-10" x 20'-10"

EXISTING FIRST FLOOR PLAN
Scale: 1/8" = 1'-0"

ARCHITECTS





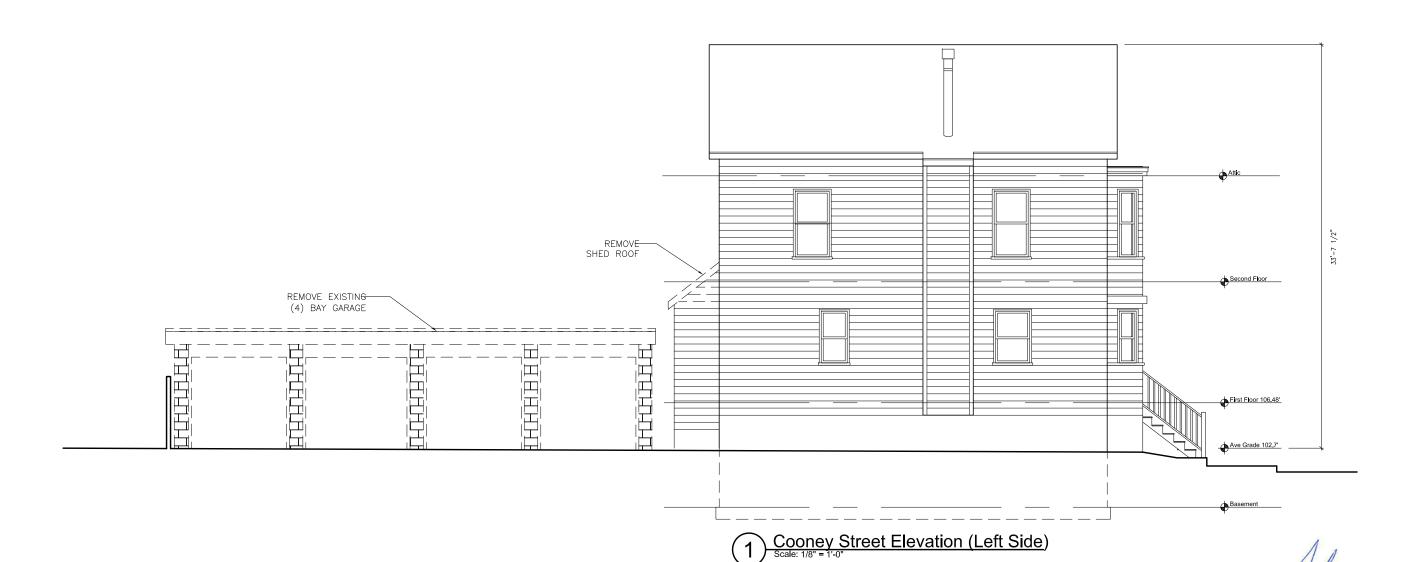

EXISTING


ELEVATIONS

ARCHITECTS GCD


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ELEVATIONS EXISTING

GCD ARCHITECTS

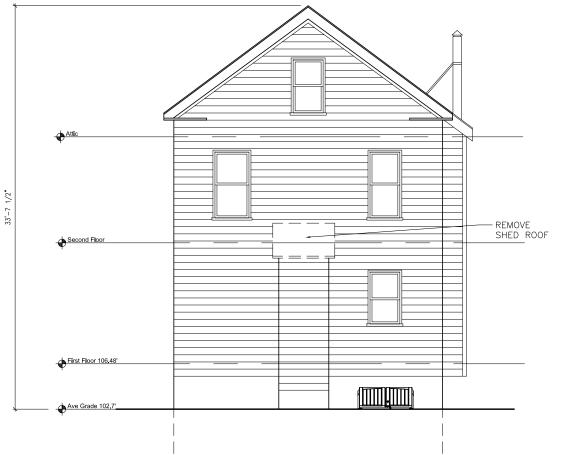

Rear Elevation
Scale: 1/8" = 1'-0"

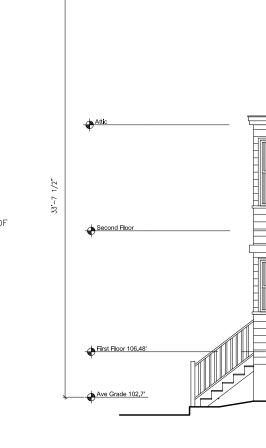

2 Right Side Elevation
Scale: 1/8" = 1'-0"

— REMOVE SHED ROOF

Somerville JULY 20, 2017 ZBA REVIEW 88 Line Street

ARCHITE

PROPOSED

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PROPOSED

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PROPOSED UNIT 2 AND UNIT 3 FLAT ROOF EXISTING GABLE ROOF 25'-2 1/4" PROPOSED (2) NEW DWELLING UNITS

PROPOSED UNIT 3 BASEMENT UNFINISHED MECHANICAL / UTILITY / STORAGE 7'-6" TOP OF SLAB TO BOTTOM OF JOISTS **UTILITY / STORAGE** 30'-10" x 20'-10"

25'-2 1/4" PROPOSED (2) NEW DWELLING UNITS

PROPOSED UNIT 2

BASEMENT UNFINISHED MECHANICAL / UTILITY / STORAGE 7'-6" TOP OF SLAB TO BOTTOM

OF JOISTS

PROPOSED BASMENT PLANS
Scale: 1/8" = 1'-0"

PROPOSED ROOF PLANS

Scale: 1/8" = 1'-0"



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EXTERIOR ELEVATIONS

PROPOSED



Line Street Elevation
Scale: 3/16" = 1'-0"


NEW CONSTRUCTION NOTES:


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PROPOSED EXTERIOR

EXISTING HOUSE: REMOVE SHINGLE SIDING, PROVIDE NEW COMPOSITE CLAPBOARD SIDING


NEW CONSTRUCTION NOTES: 1. ALL WINDOWS ALUM CLAD 2. ALL SIDING COMPOSITE CLAPBOARD



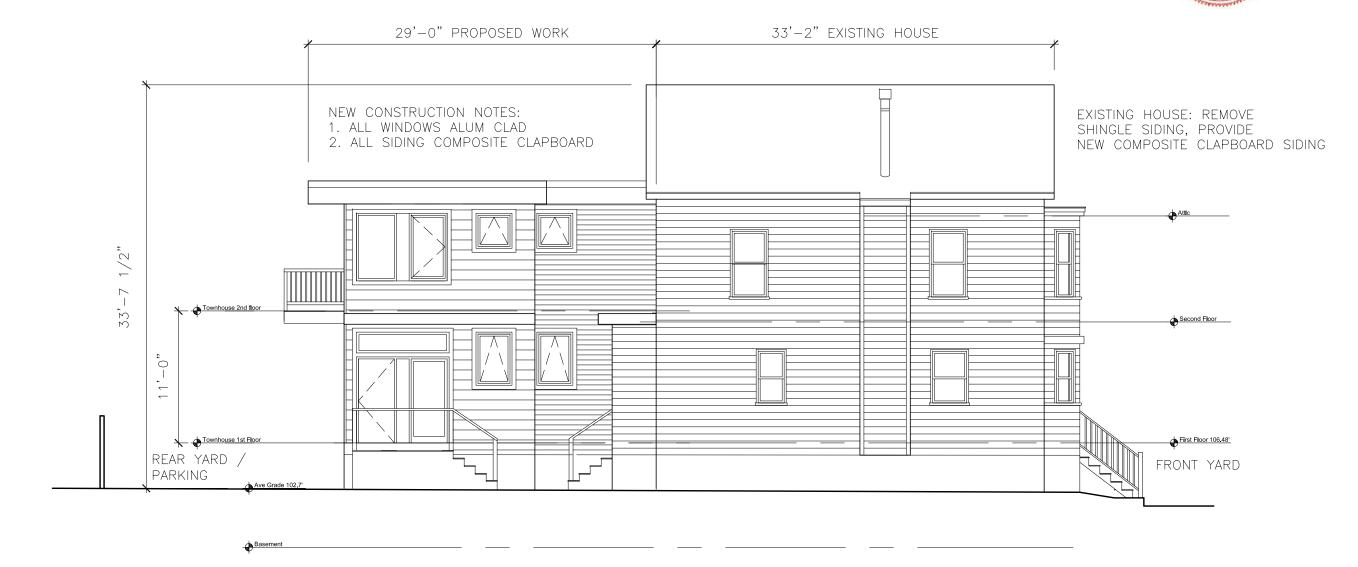

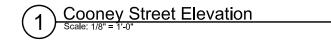
ELEVATIONS EXTERIOR

PROPOSED

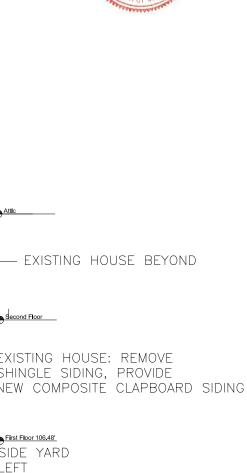



Rear Elevation

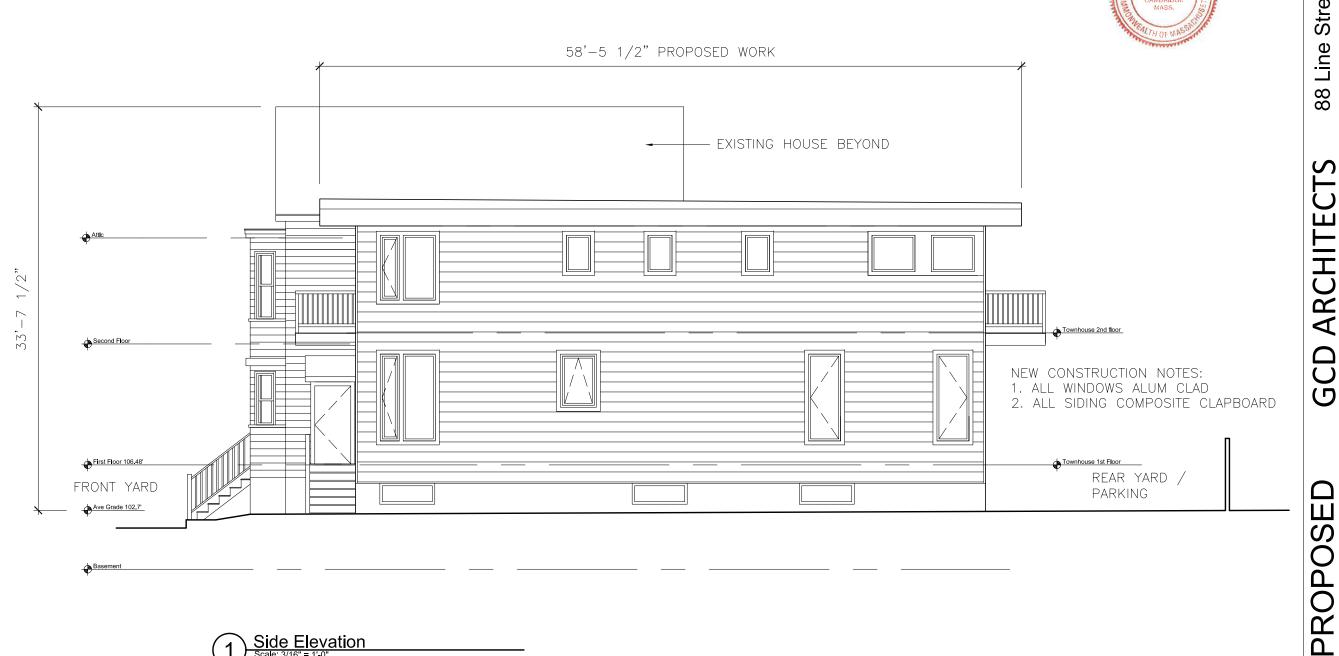

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ELEVATIONS

EXTERIOR

88 Line Street Somerville

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